CHAPTER 5: AIRPORT PLANS

Ed Carlson Memorial Field – South Lewis County Airport 2022-23 ALP Update for 2017 Airport Master Plan

<u>December 2023 Update:</u> The 2017 Airport Layout Plan (ALP) drawing set has been completely updated to align current and future design standards with the critical aircraft designations in the 2023 FAA-approved aviation activity forecasts. The ALP also includes refreshed elements from the preferred alternative presented in the previous chapter, current FAA design guidance, data from the Airports GIS (AGIS) obstruction survey, and updated aerial imagery flown specifically for the AGIS survey. The updated ALP reflects projects completed since the previous ALP was approved including the new parallel taxiway and access taxiway configuration and ongoing work to develop a new aircraft fueling facility.

This Chapter includes the full-set of Airport Layout Plan (ALP) drawings prepared as part of the Ed Carlson Memorial Field - South Lewis County Airport Master Plan Update. The proposed improvements, as depicted, include projects recommended to meet safety and demand-related needs throughout the 20-year planning period as well as additional projects identified as reserves based on the County's long-term vision for the Airport beyond the 20-year planning period.

The ALP drawings are the result of the analysis included in the various chapters of this master plan, PAC recommendations as they relate to the preferred development alternative, the County's vision for the development of the Airport, and discussions with local, state and federal officials to determine the optimum plan for a safe, efficient and economical facility. In addition, the ALP drawings have been updated to reflect airport design standards in accordance with FAA Advisory Circular (AC) 150/5070-6A, Airport Master Plans; AC 150-5300-13B, Airport Design and in conformance with the FAA Airport Layout Plan Review Checklist.

The ALP drawing set for the Ed Carlson Memorial Field - South Lewis County Airport includes the following drawing sheets:

- Sheet 1 Title Sheet
- Sheet 2 Airport Data Sheet
- Sheet 3 Airport Layout Plan (ALP) Drawing
- Sheet 4 Terminal Area Plan Drawing
- Sheet 5 Airport Airspace Drawing (Part 77)
- Sheet 6 Runway 6 -24 Approach Plan and Profile
- Sheet 7 Inner Portion Runway 06 Approach
- Sheet 8 Inner Portion Runway 24 Approach
- Sheet 9 Runway 6-24 Instrument Departure Surface
- Sheet 10 On Airport Land Use Plan
- Sheet 11 Off Airport Land Use Plan
- Sheet 12 Airport Property Plan "Exhibit A"
- Sheet 13 Airport Obstruction Data
- Sheet 14 Airport Obstruction Data

A full-sized set of these drawings is produced for the County and the FAA, which consists of 22- by 34-inch size drawing sheets. A reduced-size set (11-by-17-inch) of the drawings is included at the end of this chapter. Electronic versions of the ALP drawing set are also provided. The following sections provide a brief description of the content of each of the above-mentioned drawings.

SHEET 1 – TITLE SHEET

This drawing sheet denotes the Airport's name, FAA grant number, and an index listing the ALP drawings contained in the ALP set. This sheet also contains airport location and vicinity maps. The FAA ALP approval letter will be imbedded in this sheet for the final submittal to FAA.

SHEET 2 – AIRPORT DATA SHEET

The Airport Data Sheet contains detailed runway and taxiway dimensions, applicable FAA dimensional standards, an all-weather (VFR+IFR) wind rose, and other data reflected within the ALP drawing set.

SHEET 3 – AIRPORT LAYOUT PLAN

The ALP drawing serves as the official drawing of record for Ed Carlson Memorial Field - South Lewis County Airport. The ALP is a scaled single-page drawing depicting existing and planned improvements throughout the 20-year planning window and beyond. Specifically, this drawing depicts the current and future limits of airport property, land uses and configuration of facilities in compliance with geometric design separation and clearance standards, including airspace and navigational (NAVAID) facilities.

The ALP should be viewed as a development guide with the actual timing of improvements depending upon the aviation demand and associated improvement needs, as well as funding availability.

Some of the major components included in the ALP and discussed in previous chapters include:

- Runway-Taxiway System. No changes to Runway 6-24 or the parallel taxiway (Taxiway A) are proposed in
 the current 20-year planning period. The "ultimate" east runway extension (1,724') from the 2017 ALP is
 maintained as a long-term development reserve (beyond the planning period). This extension would
 require acquisition of property east of the existing airport boundary. Some of the same parcels
 encompass portions of the existing Runway 24 Runway Protection Zone (RPZ) see below.
- Avigation easements for the portions of the existing Runway 6 and 24 Runway Protection Zones (RPZ)
 that extend beyond airport property are recommended to protect the FAA-defined areas. The Runway 6
 RPZ extends beyond Buckley Road and the Jackson Highway, over private agricultural land. The Runway
 24 RPZ extends over several private parcels of agricultural land.
- Property acquisition (4 acres ±) is proposed east of the terminal area on the north side of the runway
 and parallel taxiway. The property acquisition is maintained from the 2017 ALP, with refinements, and
 would provide for space to develop additional aircraft parking apron for ADG I and II aircraft.

- Terminal Area Improvements. The undeveloped area adjacent to the back of the main apron is identified to accommodate future Fixed Base Operator (FBO) and related facilities. These facilities may include commercial/maintenance hangar space, operations building/terminal, a restaurant, and improved public vehicle access and parking. The proposed improvements are also compatible with future infill development (replacement) of the existing small hangar located at the east end of the flightline. Developing a large commercial hangar to support aircraft maintenance services is consistent with the County's long-term vision for the Airport.
- Other terminal area improvements include hangar taxilane upgrades (paving, resurfacing, reconstruction, widening, etc.) and replacing the existing underground AVGAS storage tank with an above ground tank (relocated to the west end of the apron). The small airplane tiedowns and taxilanes on the main apron will be reconfigured in conjunction with the fuel improvements and future apron rehabilitation.
- A future Automated Weather Observing System (AWOS) site is located on airport property, on the south side of the runway. Siting the AWOS on airport property eliminates the need and expense of acquiring additional property. This is a change to the proposed AWOS location (on the north side of the runway) depicted on the 2017 ALP. The new site was identified, evaluated, and refined following the presentation of the preliminary preferred alternative in the previous chapter. The final configuration was added the ALP drawing and reflected in the updated capital improvement program. An avigation easement is recommended to protect the portion of the FAA-defined AWOS clear area that extends over adjacent privately owned land. The purpose of the easement is to protect the operational functions of the AWOS (wind readings, etc.) that could be affected by trees, structures, or other built items.
- A 14-acre area at the southwest corner of the Airport will accommodate the future AWOS facilities noted earlier and other long-term landside facilities. As noted in the previous master plan update, the area has areas of wetlands and buffers that reduce the developable areas or may require off-site mitigation, if developed. An adjacent 26-acre privately owned parcel immediately to the east is identified for future acquisition for aviation-related development (long-term reserve).

SHEET 4 - TERMINAL AREA PLAN

The Terminal Area Plan provides additional details for existing and future landside facilities in the airport's primary terminal area that are depicted on the ALP. The drawing shows taxilane and taxiway development setbacks/separation requirements and dimensional standards, and includes general notes, data sources, and a legend noting key drawing symbols. Key existing and future facilities include:

- Apron Configuration
 - Aircraft Tiedown Positions (main apron)
 - New Aircraft Fueling Area (main apron)
 - New East Aircraft Parking Apron
- Aircraft Taxiways and Taxilanes
 - Upgrade (widen, resurface) four existing hangar stub taxilanes

- Extend/upgrade taxilane access to north hangar sites
- Aircraft Hangars, FBO Building, other buildings
 - Commercial/Tenant Operating Areas
- Access Road and Auto Parking

SHEET 5 - AIRPORT AIRSPACE PLAN (PART 77)

The Airport Airspace Plan is a scaled drawing identifying the limits of the federally defined Part 77 airspace for the Airport. The five "imaginary surfaces" for Runway 6-24 depicted, as codified in Title 14 of the <u>Code of Federal Regulations (CFR)</u>, Part 77 - Safe, Efficient Use and Preservation of the Navigable Airspace. A digital USGS map (1" = 1,000') is used as the base map for the drawing.

The surfaces defined in Part 77.25 include the primary, transitional, approach, horizontal, and conical surfaces. These surfaces were previously described in the Facility Requirements chapter and they correspond with the ultimate (reserve) runway dimensions depicted on the ALP. The recognition of the runway development reserves allows Lewis County to proactively protect the Airport's long-term development potential through appropriate land use actions.

An Airports GIS survey, completed in 2022 as part of the ALP update, provides detailed data for airfield facilities, built items, and natural items, such as trees or terrain. Obstructions are depicted in the plan view, with more detailed plan and profile views provided on other sheets in the ALP set. The Airspace Plan is supplemented by obstruction tables (see Sheets 13 and 14) detailing surveyed obstacles with recommended dispositions. The majority of the surveyed obstructions are located in the transitional and primary surfaces. The identified trees are recommended "to be removed." Roof-mounted obstruction lights are recommended for penetrating structures and other built items that cannot be easily relocated.

SHEET 6 - RUNWAY 6-24 APPROACH PLAN & PROFILE

The Approach Plan & Profile drawing depicts plan and profile views of the existing/future full length approach surfaces for Runway 6-24. The drawing identifies penetrating obstacles and non-penetrating obstacles (provided for reference only) for the 20:1 approach surfaces. The obstruction tables for the runway approaches, with recommended dispositions, are provided on Sheet 11. The AGIS survey indicates that the 20:1 approach surface for Runway 6 has one obstruction (tree - to be removed) located on airport property near the southwest corner of the primary surface at the beginning of the approach surface. Several trees and the eastern airport boundary fence that are identified as obstructions in the ultimate (reserve) runway primary surface, currently obstruct the Runway 24 approach. Removing or lowering these items is recommended to provide a clear 20:1 approach to the current runway end.

SHEETS 7 AND 8 – INNER PORTION RUNWAY 6 / RUNWAY 24 APPROACH

The Inner Approach Surface Plan and Profile drawings depict detailed views of the inner 2,000 feet of the existing/future approach surfaces and the full plan view of the runway protection zones (RPZs). The drawing identifies penetrating obstacles and non-penetrating obstacles (provided for reference only) for the surfaces that correspond to the obstruction tables provided on Sheet 11.

SHEET 9 – RUNWAY 6-24 INSTRUMENT DEPARTURE SURFACE

The Runway 6-24 Instrument Departure Surface drawing depicts the plan and profile view of the 40:1 TERPS¹ instrument departure surfaces for each runway end. The departure surfaces are applicable to runways with instrument departure procedures. Instrument departures are permitted from both Runway 6 and Runway 24, with the ATASY TWO departure. The departure requires a minimum climb of 250 feet per nautical mile upon departure to clear nearby obstacles. Similar to a runway approach surface, the departure surface is longitudinally centered on the extended runway centerline, extending outward and upward from the end of the runway.

SHEET 10 – ON-AIRPORT LAND USE PLAN

The On-Airport Land Use Plan depicts land use categories common to general aviation airports, including:

- Airport Operations Area (runway, taxiway, and protected areas)
- Aeronautical Development (aviation related development; hangars, aircraft parking, etc.)
- Runway Protection Zone (defined surfaces at runway ends); avigation easements for the portions of the
 existing RPZs that extend beyond airport property are depicted.

The land use classifications are consistent with the ALP drawing and reflect both existing and future facilities. The airport operations areas and RPZs are intended to protect the function of the runway-taxiway system. All on-airport aircraft parking and hangar development is located in the aeronautical development area. The drawing also illustrates proposed planned land acquisition and avigation easements. The land uses described in this drawing are consistent with existing zoning for the Airport and are intended to guide future development.

SHEET 11 – OFF-AIRPORT LAND USE PLAN

The Off-Airport Land Use Plan depicts the land use/zoning for the Airport and surrounding areas, consistent with current zoning ordinances. The current/future Part 77 airspace surfaces for Runway 6-24 are depicted. As noted earlier, Lewis County has land use jurisdiction for Ed Carlson Memorial Field - South Lewis County Airport and the surrounding area. County zoning consists of rural density uses oriented toward agriculture and industry. A small area of the City of Toledo residential zoning is located beneath the conical surface, just less than two miles south of the Airport.

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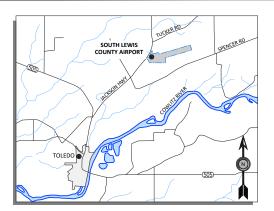
¹ TERPS: Terminal Instrument Procedures

SHEET 12 - EXHIBIT A - AIRPORT PROPERTY PLAN

Exhibit A - Airport Property Plan depicts all airport property owned or controlled by Lewis County. The drawing notes the form of ownership or control (fee simple, easement, etc.), the date of acquisition per FAA guidelines, county recording records, and the purpose for ownership. Total airport acreage is recorded as 94.93± acres, with transfer of ownership (from Towns of Winlock and Toledo to Lewis County) for the main section of the Airport listed as 2002. One authorized through-the-fence (TTF) access point for the Airport is located on the north side of the runway, east of the terminal area. This TTF access is negotiated with Peterson Estates, a residential airpark.

SHEETS 13 AND 14 – AIRPORT OBSTRUCTION TABLES


The obstacles depicted on several drawings in the ALP set are listed in tabular form on two sheets. All listed obstructions fall under their respective Part 77 surface category, or other applicable FAA surfaces (e.g., TERPS departure surface). The location, elevation information, and proposed disposition for each obstruction is provided in detail.



VICINITY MAP



AERIAL PHOTO

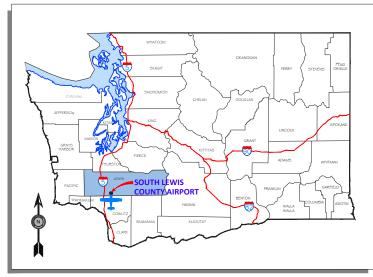

LOCATION MAP

SOUTH LEWIS COUNTY AIRPORT ED CARLSON MEMORIAL FIELD (KTDO) AIRPORT LAYOUT PLAN

LEWIS COUNTY, WASHINGTON AIP NO. 3-53-0078-013-2022 AIRPORT LAYOUT PLAN FEBRUARY 2024

SHEET INDEX

NUMBER	REV. DATE	CONTENTS
1		TITLE SHEET
2		AIRPORT DATA SHEET
3		AIRPORT LAYOUT PLAN
4		TERMINAL AREA PLAN
5		AIRPORT AIRSPACE PLAN (PART 77)
6		RUNWAY 6-24 - APPROACH PLAN & PROFILE
7		INNER PORTION RUNWAY 6 APPROACH
8		INNER PORTION RUNWAY 24 APPROACH
9		RUNWAY 6-24 INSTRUMENT DEPARTURE SURFACE
10		ON AIRPORT LAND USE PLAN
11		OFF AIRPORT LAND USE PLAN
12		EXHIBIT A - AIRPORT PROPERTY PLAN
13		AIRSPACE OBSTRUCTION DATA TABLES
14		AIRSPACE OBSTRUCTION DATA TABLES





THE PREPARATION OF THIS DOCUMENT MAY HAVE BEEN SUPPORTED, IN PART, HADOUGH THE AIRPORT IMPROVEMENT PROGRAM FINANCIAL ASSISTANCE FROM HE FEDERAL AVAITON ADMINISTRATION (PROJECT NUMBER 3-53-0078-013-2022 AS PROVIDED UNDER TITLE 49, UNITED STATES CODE, SECTION 47104. THE CONTENTS DO NOT MECESSARILY REFLECT THE OFFICIAL VIEWS OR POLICY OF THE FAA. ACCEPTANCE OF THIS REPORT BY THE FAA DOES NOT IN ANY WAY CONSTITUTE A COMMITMENT ON THE PART OF THE UNITED STATES TO PARTICIPATE IN ANY DEVELOPMENT DEPICTED THEREIN NOR DOES IT INDICATE HAT THE PROPOSED DEVELOPMENT IS ENVIRONMENTALLY ACCEPTABLE IN

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					THIS SHEET, ADJUST
					SCALES ACCORDINGLY.

FEDERAL AVIATION ADMINISTRATION APPROVAL					
APPROVAL DATE:					
SIGNATURE	-				

APPROVAL	
APPROVAL DATE:	
SIGNATURE	

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CENTURY BEND OFFICE 1020 SW EMIKAY DRIVE SUITE #100 BEND. OR 97702					
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DESIGNED BY: DM	DRAWN BY: JLS / ES	CHECKED BY: WMR	SCALE: AS SHOWN		
DATE: FEBRUA	RY 2024	PROJECT NO: 3-53-	0078-013-2022		

SOUTH LEWIS COUNTY AIRPORT ED CARLSON MEMORIAL FIELD	FIGURE NO
TITLE SHEET	SHEET NO

AIRPORT DATA						
EXISTING (E) FUTURE (F) RESERVE (R)						
AIRPORT REFERENCE CODE	A-I (SMALL)	SAME	B-II			
AIRPORT IDENTIFIER	TDO	SAME	SAME			
MEAN MAX TEMPURATURE	78.8	SAME	SAME			
AIRPORT ELEVATION	373.9'	SAME	377.0'			
AIRPORT ACREAGE	94.93	125.48	187.67			
NAVAIDS	PAPI, VASI	SAME	SAME			
AIRPORT REFERENCE POINT	46° 28' 38.03" N 122° 48' 22.23" W	SAME	46° 28' 40.19" N 122° 48' 11.50" W			
MISCELLANEOUS FACILITIES	LIGHTED WIND CONE (2), MIRL, MITL	SAME	SAME			
CRITICAL AIRCRAFT	CESSNA 182	SAME	TBD			
MAGNETIC DECLINATION, SEE NOTE 1	15° 4' E ± 0° 23'	0° 6' W ANNUALLY	0° 6' W ANNUALLY			
NPIAS SERVICE LEVEL	LOCAL	SAME	SAME			
STATE SERVICE LEVEL	COMMUNITY	SAME	SAME			

		RUNWAY DA	ATA		
	EXISTING (E)		FUTURE (F)	RESERVE (R)	
RUNWAY IDENTIFICATION		6/24	SAME	SAME	
RUNWAY DESIGN CODE - RDC		A/B-I-5000	SAME	TBD	
APPROACH REFERENCE CODE - APRC		A/B-I SMALL	SAME	TBD	
DEPARTURE REFERENCE CODE - DPRC		A/B-I SMALL	SAME	TBD	
PAVEMENT TYPE		ASPHALT	SAME	SAME	
PAVEMENT STRENGTH (PCI)		25,000 SW	25,000 SW	25,000 SW	
RUNWAY PAVEMENT STRENGTH - PCN		N/A	N/A	N/A	
RUNWAY SURFACE TREATMENT		NONE	SAME	SAME	
RUNWAY GRADIENT		0.41%	SAME	SAME	
PERCENT WIND COVERAGE			SEE WIND ROSE		
RUNWAY DIMENSIONS LENGTH AND WIDTH		4,479' x 150'	SAME	6,200' x 150'	
DISPLACED THRESHOLD		N/A	N/A	N/A	
RUNWAY END COORDINATES	RUNWAY 6	46° 28' 31.60" N 122° 48' 54.03" W	SAME	SAME	
RUNWAY END COORDINATES RUNWAY 24		46° 28' 44" N 122° 47' 52.60" W	SAME	46° 28' 48.75" N 122° 47' 29.07" W	
RUNWAY END ELEVATION	RUNWAY 6	355.5'	SAME	SAME	
	RUNWAY 24	373.9'	SAME	377.0'	
UNWAY LIGHTING		MIRL	SAME	SAME	
UNWAY PROTECTION ZONE		SEE RUNWAY DESIGN SURFACES TABLE			
RUNWAY MARKING		NPI	SAME	SAME	
L4 CFR PART 77 RUNWAY CATEGORY		UTILITY/NPI	SAME	TBD	
RUNWAY APPROACH SLOPE		20:1	SAME	TBD	
RUNWAY VISIBILITY MINIMUMS		NOT LOWER THAN 1 MILE	SAME	TBD	
AERONAUTICAL SURVEY REQUIRED		NVGS	SAME	SAME	
RUNWAY DEPARTURE SURFACE		N/A	TERPS 40:1	SAME	
RUNWAY SAFETY AREA - RSA					
RUNWAY OBJECT FREE AREA - OFA		SEE RUNWAY DESIGN SURFACES TABLE			
RUNWAY OBSTACLE FREE ZONE - OFZ					
RUNWAY VISUAL AND INSTRUMENT NAVAIDS		PAPI, REIL	SAME	SAME	
TOUCHDOWN ZONE ELEVATION	RUNWAY 6	367'	367'	367'	
	RUNWAY 24	373.9'	373.9'	380.88'	
AXIWAY AND TAXILANE SAFETY AREA - TSA					
FAXIWAY AND TAXILANE OBJECT FREE AREA - TO	FA		SEE TAXIWAY DATA TABLE		
FAXIWAY AND TAXILANE SEPARATION					
TAXIWAY AND TAXILANE LIGHTING		MITL	SAME	SAME	
HORIZONTAL DATUM		NAD83 (2011)	SAME	SAME	
VERTICAL DATUM		NAVD88	SAME	SAME	

	THROUGH THE FENCE ACCESS							
ACCESS POINT	GRANTOR	GRANTEE	INTEREST	AGREEMENT YEAR	EXPIRATION YEAR	PURPOSE		
♦	LEWIS COUNTY	PETERSON ESTATES HOMEOWNERS' ASSOCIATION	ACCESS FEE	DEC. 2003	DEC. 2023	AIRPORT ACCESS		


RUNWAY PROTECTION DATA							
RUNWAY PROTECTION ZONE (RPZ)							
INNER WIDTH LENGTH OUTER WIDTH							
EXISTING/FUTURE RUNWAY 6	250'	1,000'	450'				
EXISTING/FUTURE RUNWAY 24	250'	1,000'	450'				
RESERVE RUNWAY 6	500'	1,000'	700'				
RESERVE RUNWAY 24	500'	1,000'	700'				
RUN	IWAY SAFETY A	REA (RSA)					
	WIDTH LENGTH BEYOND RUNWAY END						
EXISTING/FUTURE RUNWAY 6/24	XISTING/FUTURE RUNWAY 6/24 120' 240'						
RESERVE RUNWAY 6/24	150'	30	10'				
RUNW	AY OBJECT FREE	E AREA (OFA)					
	WIDTH	LENGTH BEYON	D RUNWAY END				
EXISTING/FUTURE RUNWAY 6/24	250'	24	10'				
RESERVE RUNWAY 6/24	500'	30	10'				
RUNWAY OBSTACLE FREE ZONE (OFZ)							
	WIDTH	LENGTH BEYON	D RUNWAY END				
EXISTING/FUTURE RUNWAY 6/24	250	20	10'				
RESERVE RUNWAY 6/24	400'	20	10'				

DECLARED DISTANCES							
	EXISTING (E) / FUTURE (F) RESERVE (R)						
	RUNWAY 6 RUNWAY 24		RUNWAY 6	RUNWAY 24			
TORA	4,479'	4,479'	6,200'	6,200'			
TODA	4,479'	4,479'	6,200'	6,200'			
ASDA	4,479'	4,479'	6,200'	6,200'			
LDA	4,479'	4,479'	6,200'	6,200'			

NOTES:

- 1. NGS MAGNETIC DECLINATION CALCULATOR (10/13/23).
- THIS DRAWING REFLECTS PLANNING STANDARDS SPECIFIC TO THIS AIRPORT, AND IS NOT A PRODUCT OF DETAILED ENGINEERING DESIGN ANALYSIS. IT IS NO INTENDED TO BE USED FOR CONSTRUCTION OR NAVIGATION.
- 3. RESERVE RUNWAY DEVELOPMENT ARE DRAWN TO MEET RDC A/B-II STANDARDS
- ELEVATIONS (NAD83/NAVD 88) IN FEET ABOVE MEAN SEA LEVEL (MSL) AT TOP OF OBJECT. TRAVERSE WAY ELEVATIONS DO NOT INCLUDE TRAVERSE WAY ADJUSTMENT (17' FOR INTERSTATE HIGHWAYS AND 14' FOR OTHER PUBLIC ROADS.
- 5. BUILDING RESTRICTION LINE (BRL) ON NORTH SIDE PERMITS 12-FOOT STRUCTURE; BRL ON SOUTH SIDE PERMITS 15-FOOT STRUCTURE.
- 6. FURTHER PLANNING ANALYSIS REQUIRED PRIOR TO UNDERTAKING DEVELOPMENT IN THE AREA RESERVED AS "FUTURE AVIATION DEVELOPMENT (R)."
- 7. THE DESIGN STANDARD RUNWAY WIDTH FOR RDC B-I IS 60', AND 75' FOR B-II. THE EXISTING WIDTH OF 150' EXCEEDS DESIGN STANDARDS. IN KEEPING WITH THE COUNTY'S BUSINESS PLAN, IT IS THE COUNTY'S INTENT TO MAINTAIN THE RUNWAY AT THE CURRENT WIDTH. THE COUNTY ACKNOWLEDGES THAT BY EXCEEDING THE STANDARD RUNWAY WIDTH, FAA PARTICIPATION WILL BE LIMITED TO THOSE AIP ELIGIBLE PORTIONS OF A RUNWAY PROJECT THAT ARE JUSTIFIED BY THE RDC IN EFFECT AT THE TIME A GRANT OFFER IS MADE.
- 8. TAXILANES ACCESSING EXISTING HANGARS WILL REMAIN TDG 1 AND SERVICE B-I, AND SMALLER AIRCRAFT.
- 9. RUNWAY EXTENSION RESERVE DEPICTED BASED ON RDC A/B-II
- 10. AIRPORT ELEVATION AND LOCATION DETAILS VERIFIED THROUGH AN AIRPORTS GIS SURVEY (FAA APPROVED 7/27/23).

TAXIWAY DATA							
TAXIWAY A TAXIWAY A TAXILANE TAXILANE EXISTING (E) / FUTURE(F) RESERVE (R) EXISTING (E) / FUTURE (F) RESERVE (R)							
DESIGN GROUP	ADG-I/TDG-1A	ADG-II/TDG-2A	ADG-I/TDG-1A	SAME			
LIGHTING	MITL	SAME	N/A	N/A			
WIDTH	25'	35'	25'	SAME			
OBJECT FREE AREA WIDTH	89'	124'	79'	SAME			
SAFETY AREA WIDTH	49'	79'	49'	SAME			
RUNWAY SEPARATION	UNWAY SEPARATION 272' SAME N/A N/A						

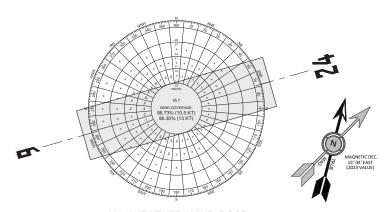

ALL-WEATHER WIND ROSE

SOURCE: CLS ASOS.

WIND DATA ACCESSED FROM NATIONAL CLIMATE DATA CENTER (NCDC)
INTEGRATED SURFACE HOURLY / INTEGRATED SURFACE DATE
(ISH/ISD) INVENTORY

PERIOD: 2011 TO 2020

RUNWAY WIND COVERAGE						
RUNWAY	CROSSWIND COMP.		VFR WIND	IFR WIND		
ALIGNMENT	(KNOTS)	COVERAGE	COVERAGE	COVERAGE		
RUNWAY 6	10.5	58.44%	56.13%	73.41%		
KUNWATE	13	58.78%	56.52%	73.46%		
RUNWAY 24	10.5	81.91%	81.32%	85.24%		
	13	83.15%	82.66%	85.62%		
COMBINED	10.5	96.73%	96.43%	99.03%		
	13	98.30%	98.16%	99.46%		

"THE PREPARATION OF THIS DOCUMENT MAY HAVE BEEN SUPPORTED, IN PART, THROUGH THE AURPORT IMPROVEMENT PROGRAM FINANCIAL ASSISTANCE FROM THE FEDERAL AVAITION ADMINISTRATION (PROJECT INJURES -35-30078 013-2022) AS PROVIDED UNDER TITLE 49, UNITED STATES CODE, SECTION 47.104. THE CONTENTS DO NOT NECESSARILY REFLECT THE OFFICIAL VIEWS OR POLICY OF THE FAA. ACCEPTANCE OF THIS REPORT BY THE FAA DOES NOT IN ANY WAY CONSTITUTE A COMMITMENT ON THE PART OF THE UNITED STATES TO PARTICIPATE IN ANY DEVELOPMENT IS ENTO FOR THE FINE THE STATES TO PARTICIPATE IN ANY DEVELOPMENT IS ENVIRONMENTALLY ACCEPTABLE IN ACCORDANCE WITH APPROPRIATE PUBLIC LAWS."



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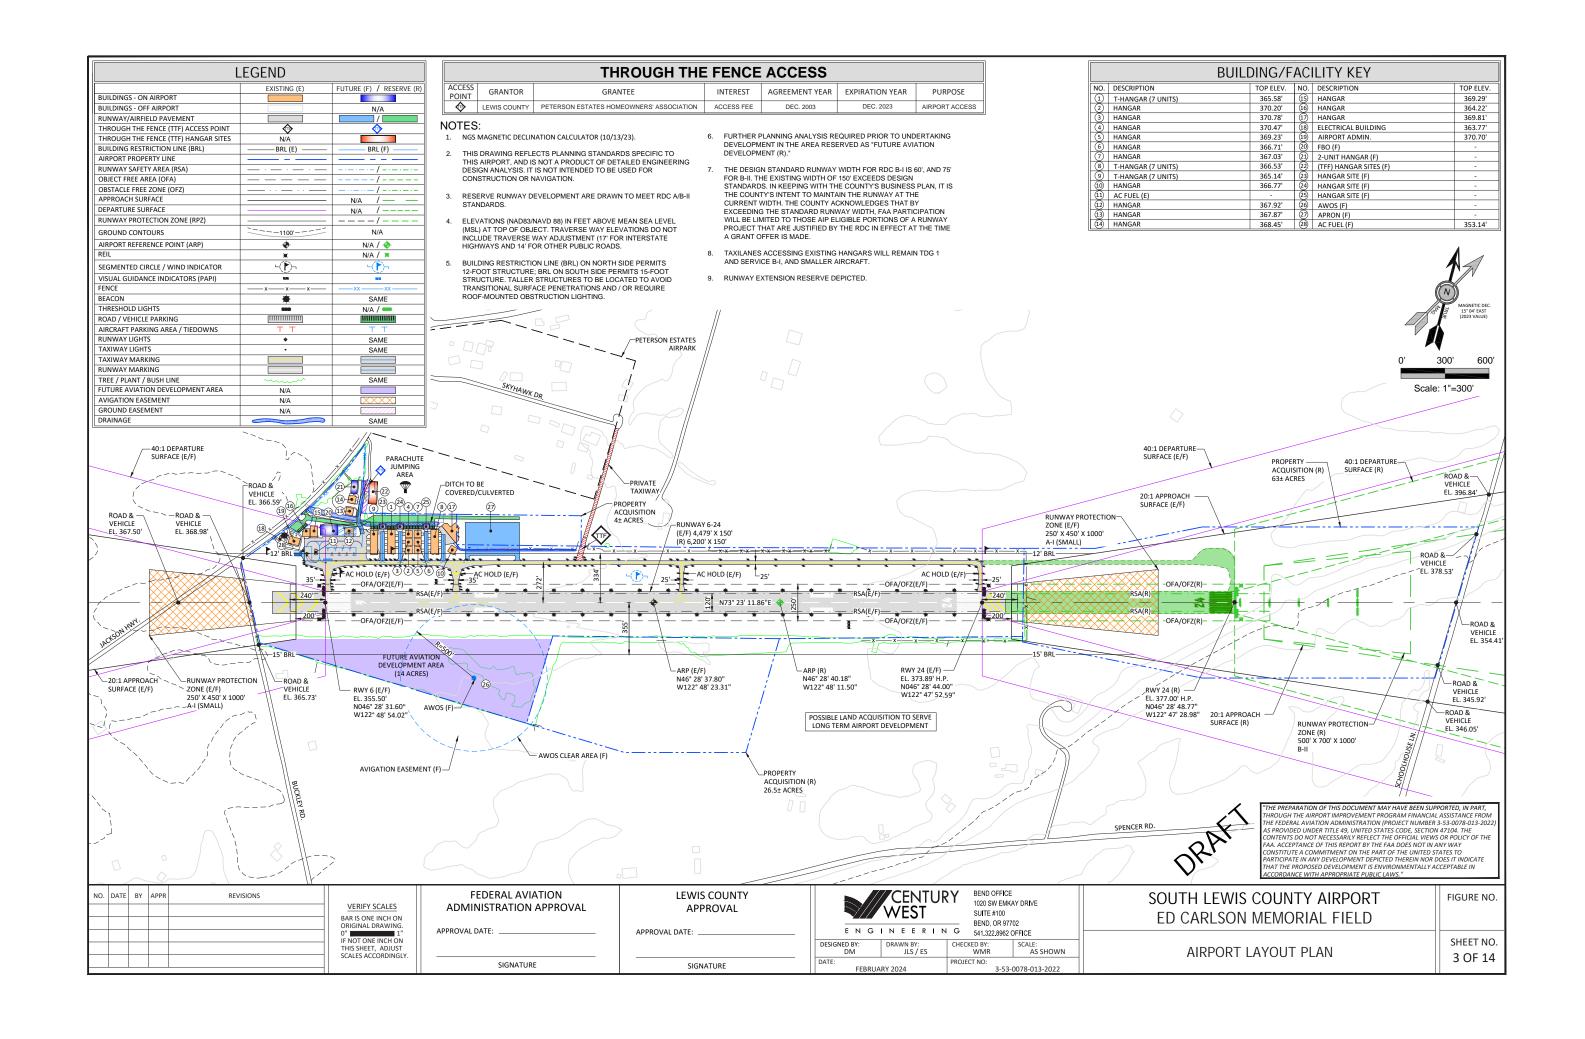
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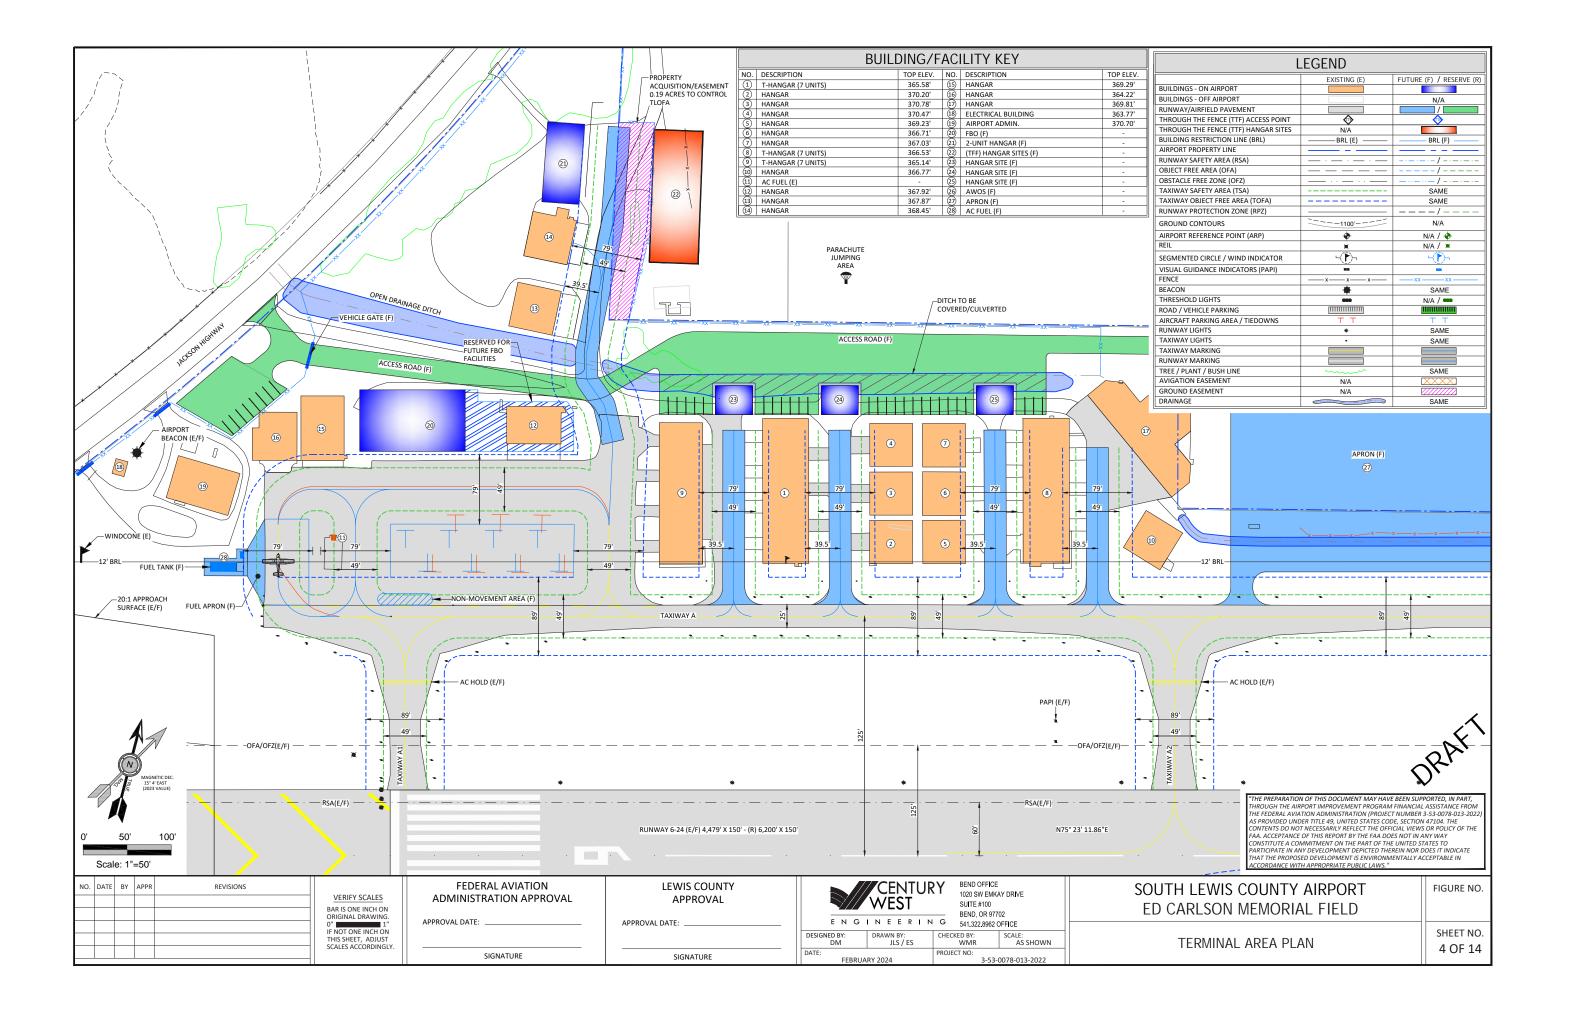
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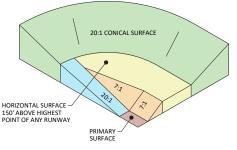
	CENTUR WEST	BEND OFFICE 1020 SW EMK/ SUITE #100 BEND, OR 977	AY DR I VE
E N G	INEERIN		
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SOUTH LEWIS COUNTY AIRPORT ED CARLSON MEMORIAL FIELD	FIGURE NO.
AIRPORT DATA SHEET	SHEET NO. 2 OF 14





RUNWAY 6/24 PART 77 DIMENSIONAL STANDARDS UTILITY NON-PRECISION INSTRUMENT (EXISTING/FUTURE) RUNWAY EXISTING LENGTH = 4.479' (RUNWAY TYPE = A-I / B-I SMALL) RUNWAY FUTURE LENGTH = 6,200' (RUNWAY TYPE = A-II / B-II SMALL) **RUNWAY 6** PRIMARY SURFACE WIDTH = 500' APPROACH SURFACE INNER WIDTH = 500' APPROACH SURFACE OUTER WIDTH = 2,000' APPROACH SURFACE LENGTH = 5,000' RADIUS OF HORIZONTAL SURFACE = 5,000' APPROACH SLOPE = 20:1 **RUNWAY 24** PRIMARY SURFACE WIDTH = 500' APPROACH SURFACE INNER WIDTH = 500' APPROACH SURFACE OUTER WIDTH = 2,000' APPROACH SURFACE LENGTH = 5,000' RADIUS OF HORIZONTAL SURFACE = 5,000' APPROACH SLOPE = 20:1



TYPICAL ISOMETRIC VIEW OF F.A.R. PART 77 SURFACES (CUT ON RUNWAY CENTERLINE)

LEGEND

- ▲ OBSTACLE
- NON-LISTED OBSTACLE

NOTES:

NO. DATE BY APPR


- 1. DETAILED DATA ARE PROVIDED FOR OBSTACLES (SEE LEGEND) THAT ARE LESS THAN 10' BELOW THE CONTROLLING SURFACE OR ABOVE. THE LOCATIONS OF OTHER OBSTACLES ARE DEPICTED BY BLACK DOTS FOR REFERENCE. CONSULT ADIP FOR DETAILED INFORMATION ON THESE
- AREAS OF DENSE OBSTACLES ARE AGGREGATED BY CANOPY
 BOUNDARIES (TRANSITIONAL) OR GRIDS (HORIZONTAL/CONICAL), THE OBSTACLE ID NUMBER OF THE MOST PENETRATING OBSTACLE FOR EACH AREA IS LISTED ON THE PLAN VIEW AND REFERENCED IN THE OBSTRUCTION TABLES ON SHEETS 13 AND 14.
- 3. SEE SHEET 6 FOR APPROACH PLAN AND PROFILE.
- 4. PART 77 SURFACES BASED ON RESERVE AIRSPACE SURFACES.
- 5. AIRPORT ELEVATION AND LOCATION DETAILS VERIFIED THROUGH AN AIRPORTS GIS SURVEY (FAA APPROVED 7/27/23).


THE PREPARATION OF THIS DOCUMENT MAY HAVE BEEN SUPPORTED, IN PART, I'HROUGH THE AIRPORT IMPROVEMENT PROGRAM FINANCIAL ASSISTANCE FROM I'HE FEDERAL AVIATION ADMINISTRATION (PROJECT NUMBER 3-53-0078-013-2022 S PROVIDED UNDER TITLE 49. UNITED STATES CODE. SECTION 47104. THE ONTENTS DO NOT NECESSARILY REFLECT THE OFFICIAL VIEWS OR POLICY OF THE CONTENTS DO NOT NECESSARILY REFLECT THE OFFICIAL VIEWS OR POLICY OF TH FAA. ACCEPTANCE OF THIS REPORT BY THE FAA DOES NOT IN ANY WAY CONSTITUTE A COMMITMENT ON THE PART OF THE UNITED STATES TO PARTICIPATE IN ANY DEVELOPMENT DEPICTED THEREIN NOR DOES IT INDICATE THAT THE PROPOSED DEVELOPMENT IS ENVIRONMENTALLY ACCEPTABLE IN ACCORDANCE WITH APPROPRIATE PUBLIC LAWS."




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IF NOT ONE INCH ON THIS SHEET, ADJUST SCALES ACCORDINGLY.

SHEET NO. 5 OF 14

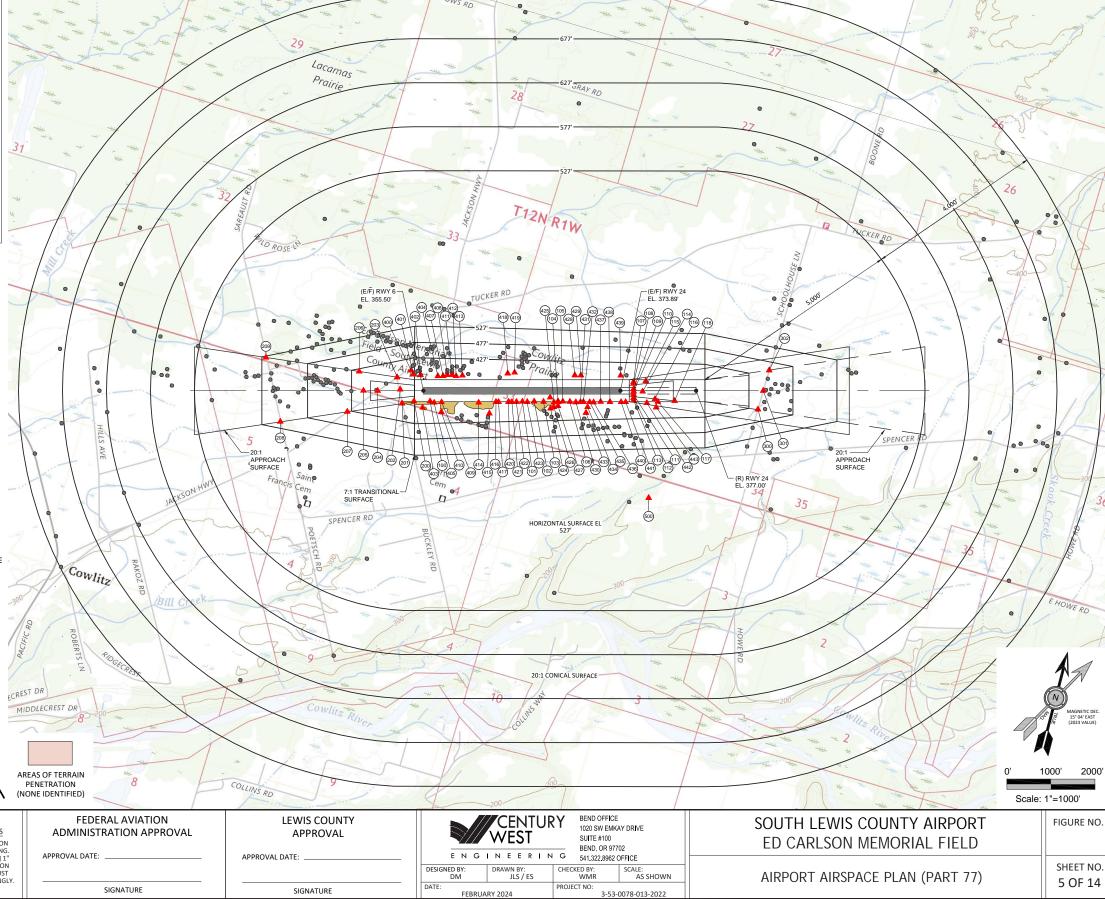

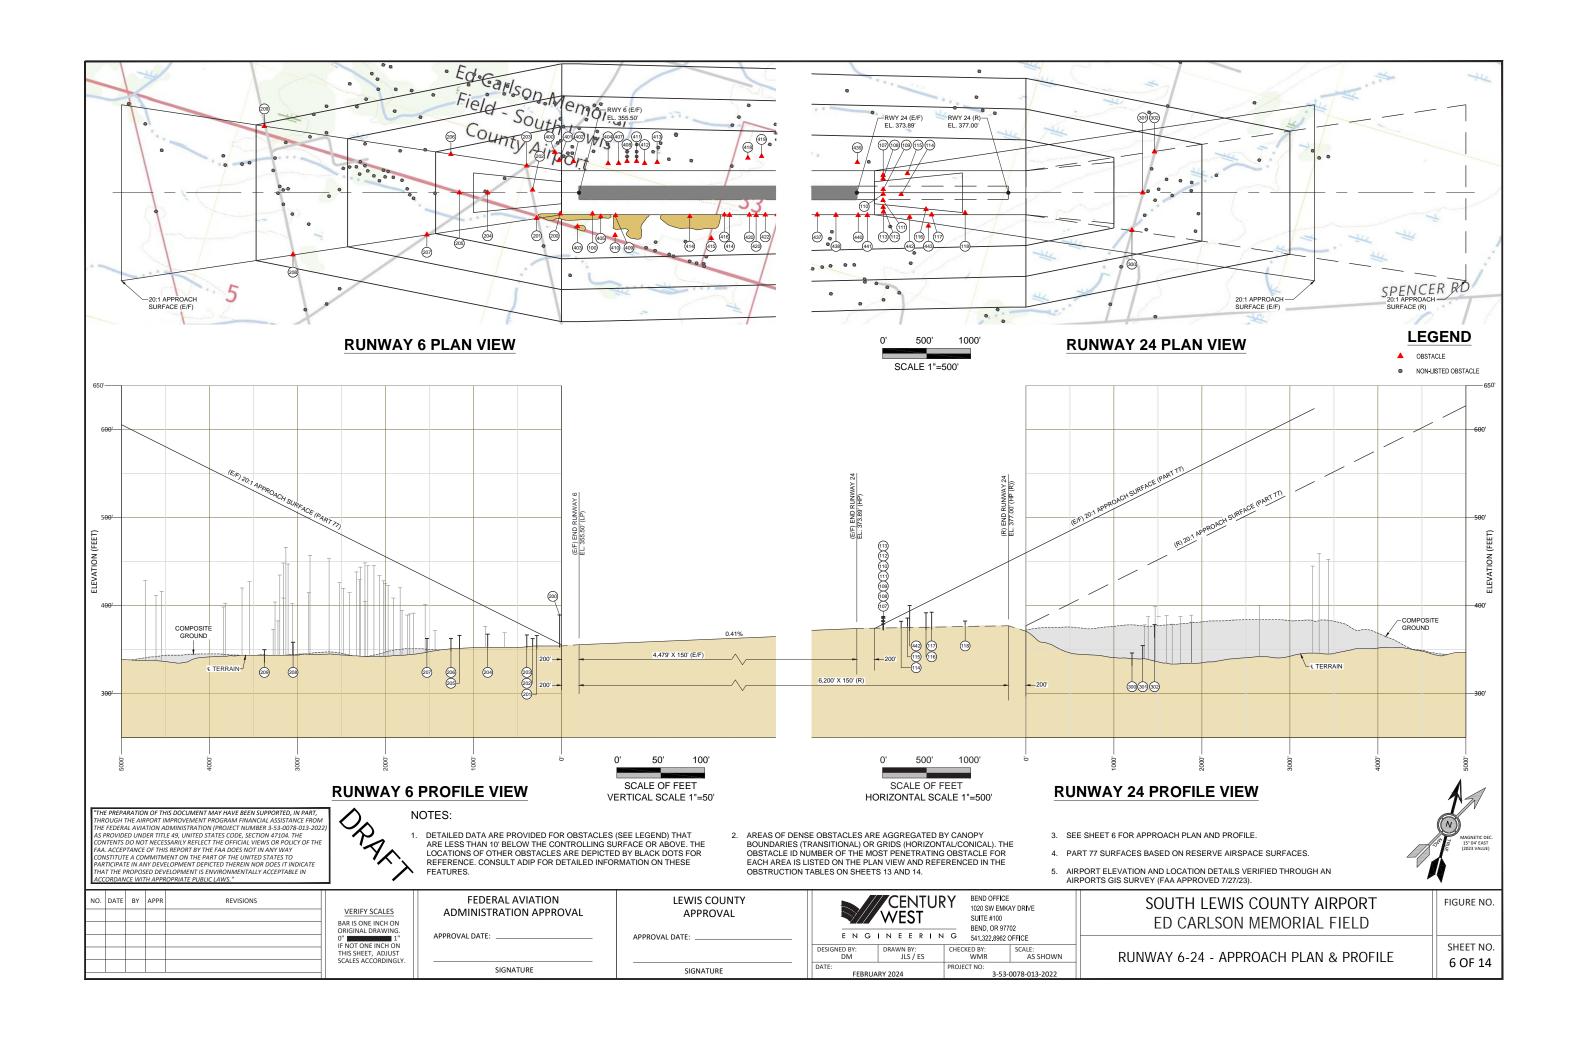



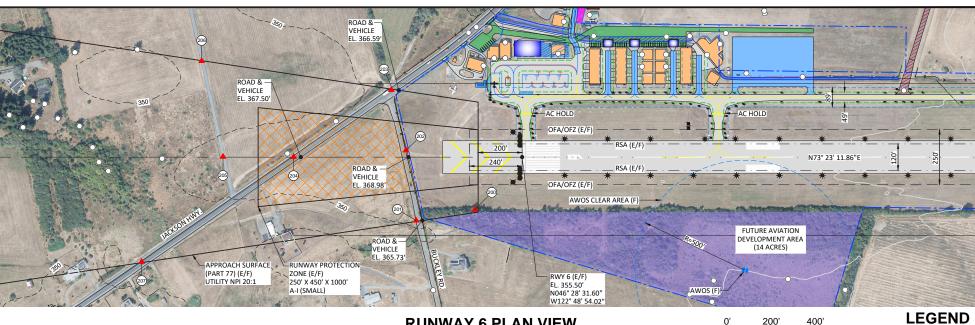

RUNWAY 6 PLAN VIEW





NOTES:

- 1. DETAILED DATA ARE PROVIDED FOR OBSTACLES (SEE LEGEND) THAT ARE LESS THAN 10' BELOW THE CONTROLLING SURFACE OR ABOVE. THE LOCATIONS OF OTHER OBSTACLES ARE DEPICTED BY BLACK DOTS FOR REFERENCE. CONSULT ADIP FOR DETAILED INFORMATION ON THESE
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					IF NOT ONE INCH ON THIS SHEET, ADJUST SCALES ACCORDINGLY

FEDERAL AVIATION ADMINISTRATION APPROVAL
APPROVAL DATE:

SIGNATURE

475' -

450'

400'

325'

APPROVAL	
APPROVAL DATE:	_
SIGNATURE	-

LEWIS COUNTY

20'

Vertical Scale: 1"=20'

E N G	CENTUR	SUITE #100	AY DR I VE
	WEST	BEND, OR 977	02
DESIGNED BY:	DRAWN BY:	CHECKED BY:	SCALE:
DM	JLS / ES	WMR	AS SHOWN
DATE:	DV 2024	PROJECT NO:	0078 012 2022

RUNWAY 6 PROFILE VIEW

203 202(20)

SOUTH LEWIS COUNTY AIRPORT	FIGURE NO
ED CARLSON MEMORIAL FIELD	
	SHEET NO


200'

Horizontal Scale: 1"=200'

400'

INNER PORTION RUNWAY 6 APPROACH 7 OF 14



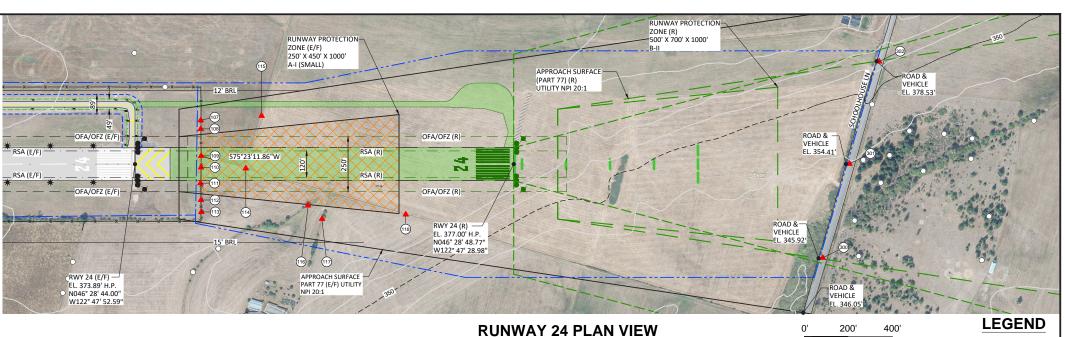

NOTES:

- 1. DETAILED DATA ARE PROVIDED FOR OBSTACLES (SEE LEGEND) THAT ARE LESS THAN 10' BELOW THE CONTROLLING SURFACE OR ABOVE. THE LOCATIONS OF OTHER OBSTACLES ARE DEPICTED BY BLACK DOTS FOR REFERENCE. CONSULT ADIP FOR DETAILED INFORMATION ON THESE
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- 3. SEE SHEET 6 FOR APPROACH PLAN AND PROFILE.
- 4. PART 77 SURFACES BASED ON RESERVE AIRSPACE SURFACES.
- 5. AIRPORT ELEVATION AND LOCATION DETAILS VERIFIED THROUGH AN AIRPORTS GIS SURVEY (FAA APPROVED 7/27/23).
- 6. OBSTACLES #107-113 ARE LISTED AS ULTIMATE PRIMARY SURFACE OBSTRUCTIONS; THESE ITEMS PENETRATE THE EXISTING RWY 24
 APPROACH SURFACE.

"THE PREPARATION OF THIS DOCUMENT MAY HAVE BEEN SUPPORTED, IN PART, THROUGH THE AIRPORT IMPROVEMENT PROGRAM FINANCIAL ASSISTANCE FROM THE FEDERAL AVIATION ADMINISTRATION (PROJECT NUMBER 3-53-0078-013-2022) AS PROVIDED UNDER TITLE 49, UNITED STATES CODE, SECTION 47104. THE CONTENTS DO NOT NECESSARILY REFLECT THE OFFICIAL VIEWS OR POLICY OF THE CONTENTS DO NOT INCEESSABILY REFLECT THE OFFICIAL VIEWS OR POLICY OF TH FAA. ACCEPTANCE OF THIS REPORT BY THE FAA DOES NOT IN ANY WAY CONSTITUTE A COMMITMENT ON THE PART OF THE UNITED STATES TO PARTICIPATE IN ANY DEVELOPMENT DEPICTED THEREIN NOR DOES IT INDICATE THAT THE PROPOSED DEVELOPMENT IS ENVIRONMENTALLY ACCEPTABLE IN ACCORDANCE WITH APPROPRIATE PUBLIC LAWS."



REAL TO

Ю.	DATE	BY	APPR	REVISIONS	
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					THIS SHEET, ADJUST
					SCALES ACCORDINGLY.

FEDERAL AVIATION ADMINISTRATION APPROVAL	LEWIS COUNTY APPROVAL
APPROVAL DATE:	APPROVAL DATE:
SIGNATURE	SIGNATURE

114 (15)

20'

Vertical Scale: 1"=20'

6,200' X 150' (R)

	CENTUR	BEND OFFICE	
E N G	WEST	SUITE #100 —— BEND, OR 977	02
DESIGNED BY: DM	DRAWN BY: JLS / ES	CHECKED BY: WMR	SCALE: AS SHOWN
DATE: FEBRUA	RY 2024	PROJECT NO: 3-53-	0078-013-2022

RUNWAY 24 PROFILE VIEW

`	
SOUTH LEWIS COUNTY AIRPORT	FIGURE NO.
ED CARLSON MEMORIAL FIELD	
INNER PORTION RUNWAY 24 APPROACH	SHEET NO. 8 OF 14

200'

Horizontal Scale: 1"=200'

400'

Scale: 1"=200'

- COMPOSITE GROUND


▲ OBSTACLE


O NON-LISTED OBSTACLE


- 450'


400'

- 325'

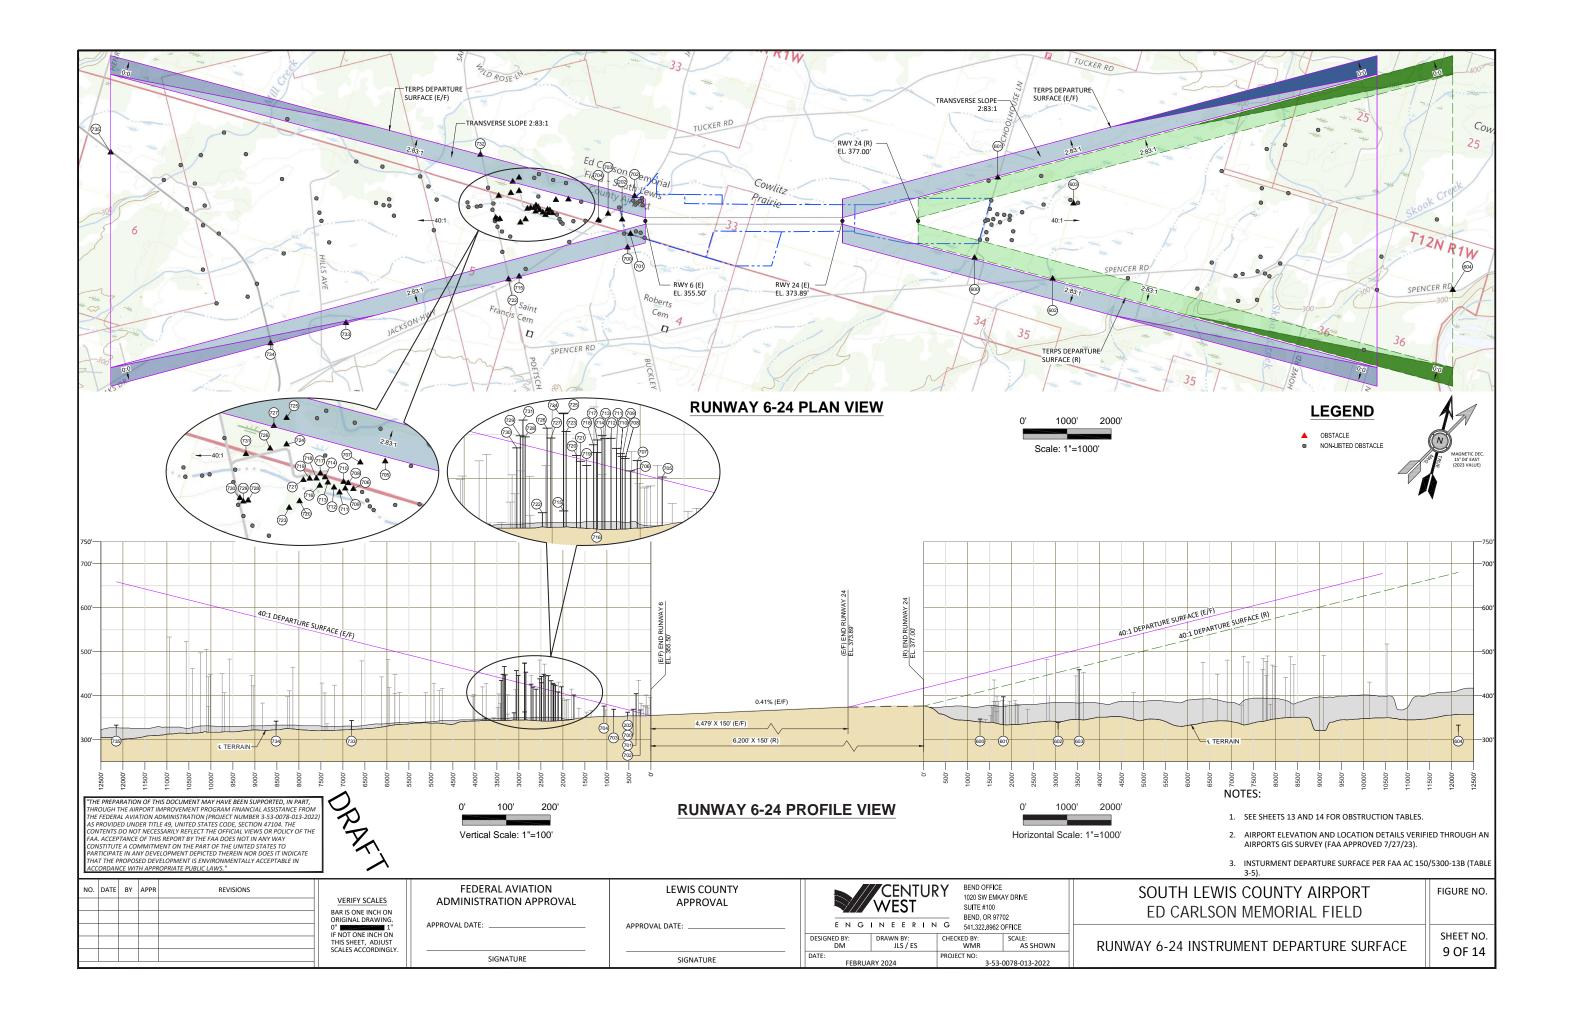

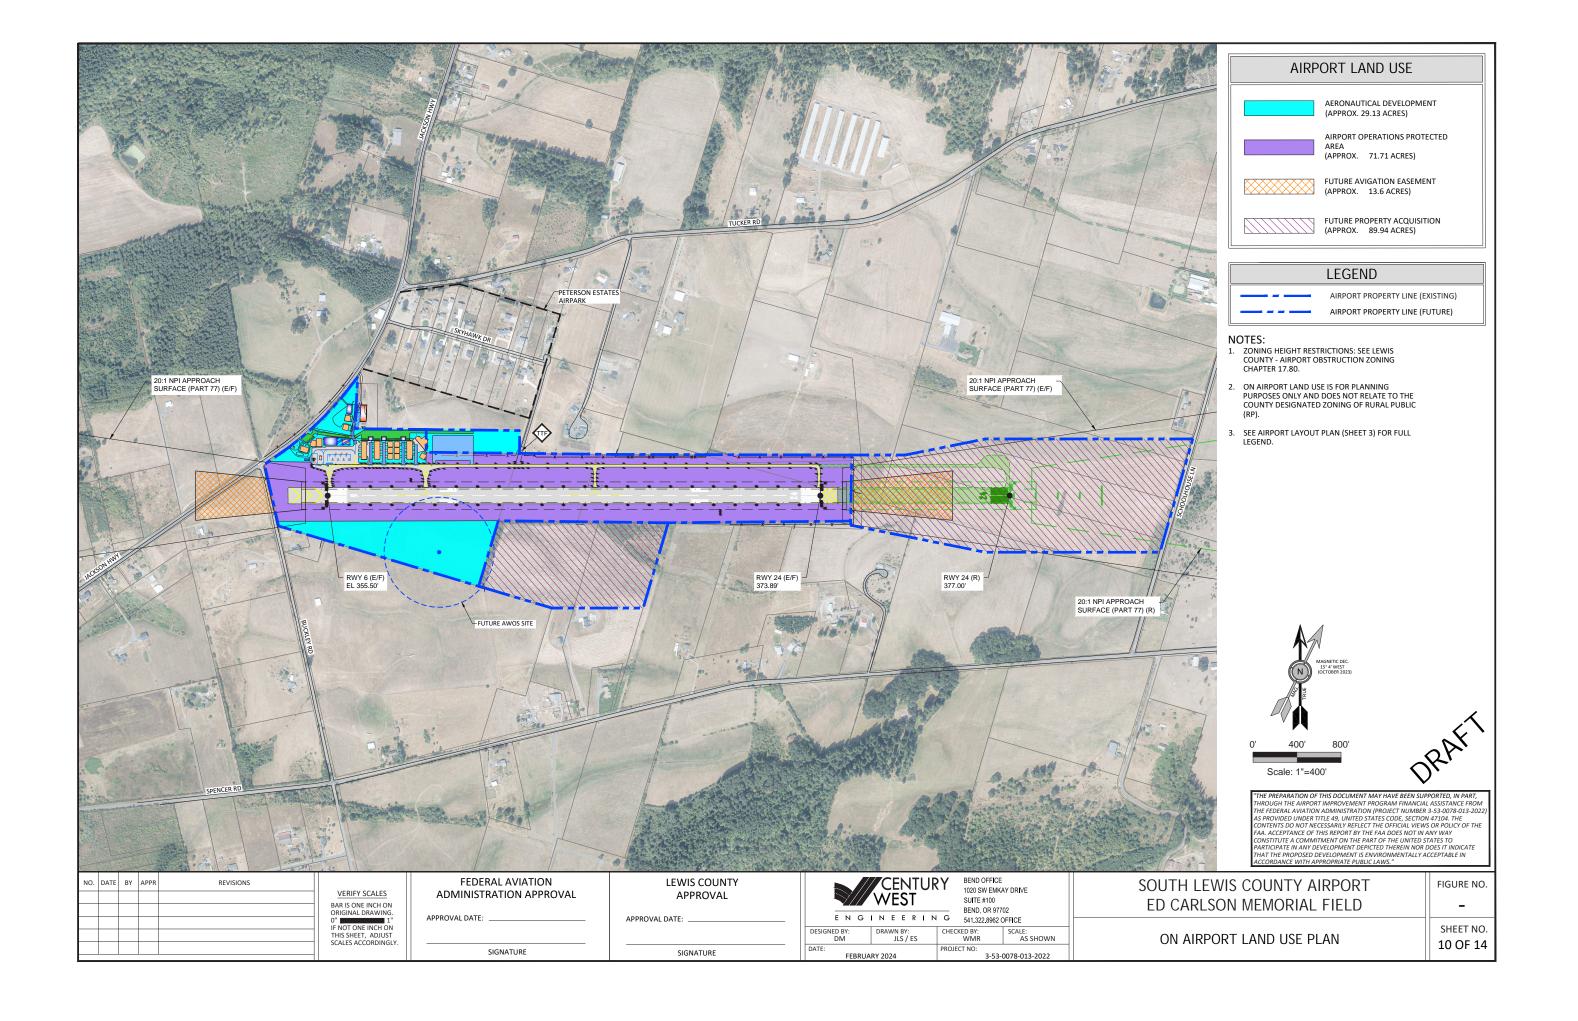

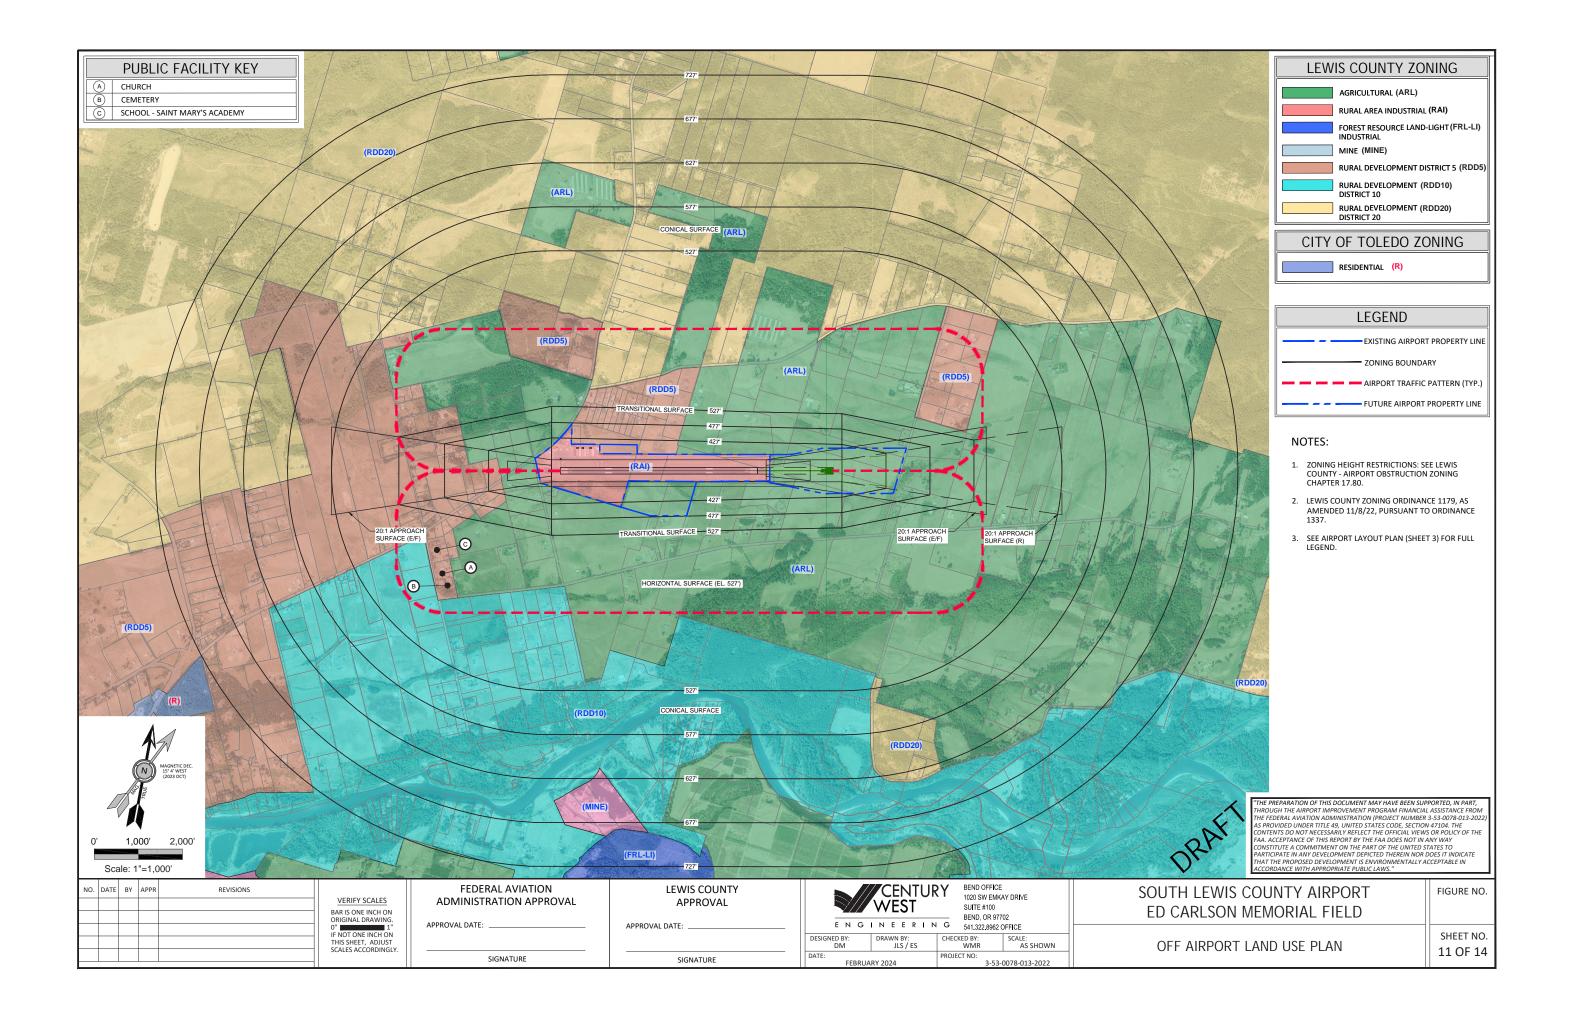

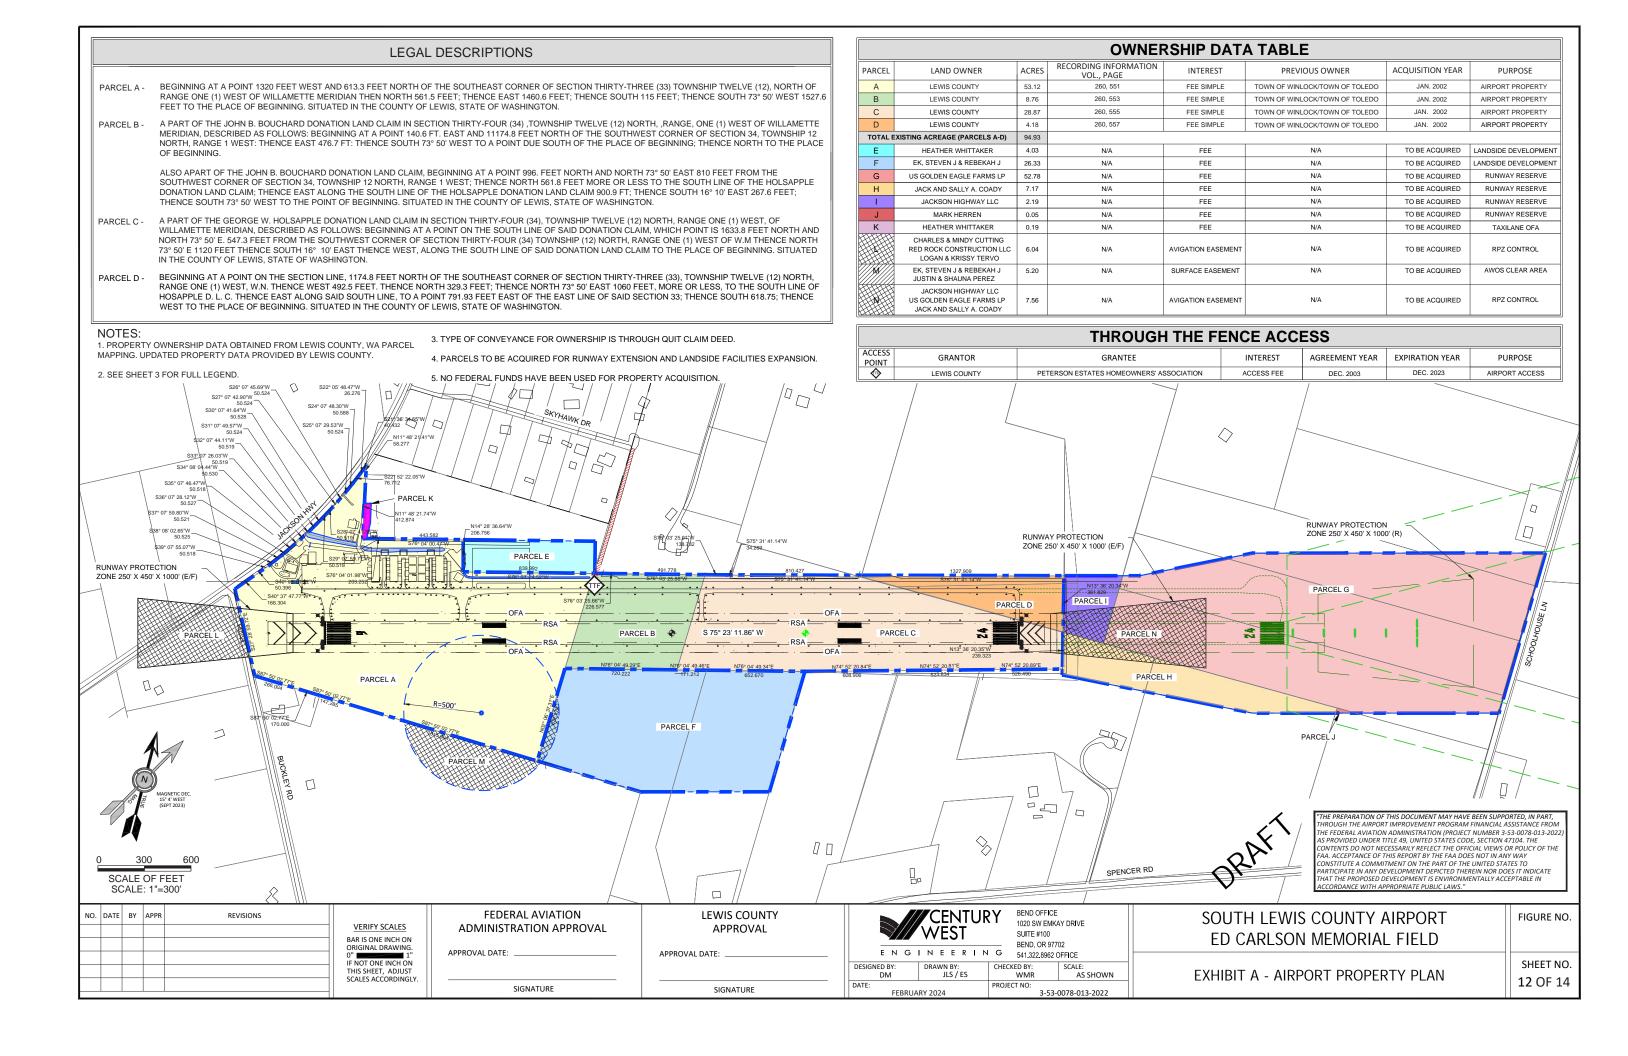

	PART 77 RUNWAY 6 APPROACH SURFACE OBSTRUCTIONS										
OBSTACLE ID	DESCRIPTION	SURVEY DATE	SURFACE	GROUND ELEVATION (FT)	AGL (FT)	TOP HEIGHT (FT)	SURFACE HEIGHT (FT)	PENETRATION (FT)	DISPOSITION		
200	TREE	8/31/2022	APPROACH 06	352.3	37.0	389.3	356.2	33.1	TO BE REMOVED		
201	BUCKLEY ROAD	8/31/2022	APPROACH 06	350.8	15.0	365.8	369.6	-3.8	NO OBSTRUCTION		
202	TREE	8/31/2022	APPROACH 06	353.8	8.6	362.4	371.9	-9.5	NO OBSTRUCTION		
203	JACKSON HWY	8/31/2022	APPROACH 06	351.6	15.0	366.6	375.2	-8.6	NO OBSTRUCTION		
204	JACKSON HWY	8/31/2022	APPROACH 06	352.5	15.0	367.5	397.4	-29.9	NO OBSTRUCTION		
205	SECONDARY ROAD	8/31/2022	APPROACH 06	351.1	10.0	361.1	413.5	-52.4	NO OBSTRUCTION		
206	SECONDARY ROAD	8/31/2022	APPROACH 06	347.7	10.0	357.7	418.3	-60.6	NO OBSTRUCTION		
207	JACKSON HWY	8/31/2022	APPROACH 06	347.6	15.0	362.6	432.0	-69.4	NO OBSTRUCTION		
208	PRIMARY ROAD	8/31/2022	APPROACH 06	343.3	15.0	358.3	508.0	-149.8	NO OBSTRUCTION		
209	PRIMARY ROAD	8/31/2022	APPROACH 06	334.8	15.0	349.8	524.3	-174.5	NO OBSTRUCTION		

PART 77 RUNWAY 24 APPROACH SURFACE OBSTRUCTIONS										
OBSTACLE ID	DESCRIPTION	SURVEY DATE	SURFACE	GROUND ELEVATION (FT)	AGL (FT)	TOP HEIGHT (FT)	SURFACE HEIGHT (FT)	PENETRATION (FT)	DISPOSITION	
300	PRIMARY ROAD	8/31/2022	APPROACH 24	331.2	15.0	346.2	437.3	-91.1	NO OBSTRUCTION	
301	PRIMARY ROAD	8/31/2022	APPROACH 24	339.6	15.0	354.6	443.4	-88.8	NO OBSTRUCTION	
302	PRIMARY ROAD	8/31/2022	APPROACH 24	363.4	15.0	378.4	450.1	-71.7	NO OBSTRUCTION	

	PART 77 HORIZONTAL SURFACE OBSTRUCTIONS										
OBSTA ID	CLE D	DESCRIPTION	SURVEY DATE	SURFACE	GROUND ELEVATION (FT)	AGL (FT)	TOP HEIGHT (FT)	SURFACE HEIGHT (FT)	PENETRATION (FT)	DISPOSITION	
500		TREE	8/31/2022	HORIZONTAL	325.9	192.6	518.5	527.0	-8.5	NO OBSTRUCTION	

	PART 77 PRIMARY SURFACE OBSTRUCTIONS											
OBSTACLE ID	DESCRIPTION	SURVEY DATE	SURFACE	GROUND ELEVATION (FT)	AGL (FT)	TOP HEIGHT (FT)	SURFACE HEIGHT (FT)	PENETRATION (FT)	DISPOSITION			
100	TREE	8/31/2022	PRIMARY	353.9	43.2	397.1	356.0	41.1	TO BE REMOVED			
101	TREE	8/31/2022	PRIMARY	360.8	21.0	381.8	363.6	18.3	TO BE REMOVED			
102	TREE	8/31/2022	PRIMARY	395.8	7.0	402.8	364.7	38.1	TO BE REMOVED			
103	TREE	8/31/2022	PRIMARY	362.6	24.4	387.0	365.8	21.2	TO BE REMOVED			
104	TREE	8/31/2022	PRIMARY	364.8	24.9	389.7	367.3	22.4	TO BE REMOVED			
105	TREE	8/31/2022	PRIMARY	365.2	21.0	386.2	367.9	18.4	TO BE REMOVED			
106	TREE	8/31/2022	PRIMARY	366.3	22.5	388.8	368.6	20.2	TO BE REMOVED			
107	FENCE	8/31/2022	PRIMARY	374.7	4.6	379.4	374.4	4.9	TO BE REMOVED			
108	TREE	8/31/2022	PRIMARY	374.4	7.5	381.9	374.4	7.5	TO BE REMOVED			
109	FENCE	8/31/2022	PRIMARY	374.8	4.8	379.6	374.4	5.2	TO BE REMOVED			
110	TREE	8/31/2022	PRIMARY	373.9	11.7	385.6	374.4	11.2	TO BE REMOVED			
111	TREE	8/31/2022	PRIMARY	372.7	9.9	382.6	374.4	8.2	TO BE REMOVED			
112	TREE	8/31/2022	PRIMARY	371.7	15.0	386.8	374.4	12.3	TO BE REMOVED			
113	TREE	8/31/2022	PRIMARY	371.9	15.8	387.7	374.4	13.2	TO BE REMOVED			
114	TREE	8/31/2022	PRIMARY	373.8	8.3	382.1	374.8	7.3	TO BE REMOVED			
115	TREE	8/31/2022	PRIMARY	376.1	9.7	385.9	374.9	10.9	TO BE REMOVED			
116	TREE	8/31/2022	PRIMARY	371.9	19.9	391.8	375.3	16.5	TO BE REMOVED			
117	TREE	8/31/2022	PRIMARY	372.8	19.6	392.4	375.4	17.0	TO BE REMOVED			
118	FENCE	8/31/2022	PRIMARY	377.5	4.9	382.4	376.1	6.3	TO BE REMOVED			

Mate Mate	SPOSITION
400 BEACON 8/31/2022 TRANSITIONAL 354.6 80.2 434.9 387.6 47.3 101 401 FLAGPOLE 8/31/2022 TRANSITIONAL 354.6 28.3 382.8 373.5 9.3 F 402 UNKNOWN POLE 8/31/2022 TRANSITIONAL 352.3 19.8 372.1 370.9 1.3 TO I 403 TREE 8/31/2022 TRANSITIONAL 356.8 38.8 395.6 374.7 21.0 TO I 404 BUILDING 8/31/2022 TRANSITIONAL 353.3 20.1 373.4 368.2 5.1 TO 405 TREE 8/31/2022 TRANSITIONAL 354.2 59.1 413.3 359.2 54.1 TO I	or comon
402 UNKNOWN POLE 8/31/2022 TRANSITIONAL 352.3 19.8 372.1 370.9 1.3 TO I 403 TREE 8/31/2022 TRANSITIONAL 356.8 38.8 395.6 374.7 21.0 TO I 404 BUILDING 8/31/2022 TRANSITIONAL 353.3 20.1 373.4 368.2 5.1 TO 405 TREE 8/31/2022 TRANSITIONAL 354.2 59.1 413.3 359.2 54.1 TO I	BE REMOVED
403 TREE 8/31/2022 TRANSITIONAL 356.8 38.8 395.6 374.7 21.0 TO I 404 BUILDING 8/31/2022 TRANSITIONAL 353.3 20.1 373.4 368.2 5.1 TO 405 TREE 8/31/2022 TRANSITIONAL 354.2 59.1 413.3 359.2 54.1 TO I	RELOCATE
404 BUILDING 8/31/2022 TRANSITIONAL 353.3 20.1 373.4 368.2 5.1 TO 405 TREE 8/31/2022 TRANSITIONAL 354.2 59.1 413.3 359.2 54.1 TO	BE REMOVED
405 TREE 8/31/2022 TRANSITIONAL 354.2 59.1 413.3 359.2 54.1 TO I	BE REMOVED
	D BE LIGHTED
406 WIND SOCK 8/31/2022 TRANSITIONAL 353.7 35.9 389.5 368.7 20.8 TO	BE REMOVED
	D BE LIGHTED
407 BUILDING 8/31/2022 TRANSITIONAL 353.9 20.3 374.2 368.7 5.5 TO	D BE LIGHTED
408 BUILDING 8/31/2022 TRANSITIONAL 354.3 22.2 376.5 372.5 4.0 TO	D BE LIGHTED
409 TREE 8/31/2022 TRANSITIONAL 354.3 67.5 421.8 358.6 63.2 TO I	BE REMOVED
410 TREE 8/31/2022 TRANSITIONAL 356.8 45.0 401.9 390.2 11.7 TO	BE REMOVED
411 BUILDING 8/31/2022 TRANSITIONAL 353.8 22.9 376.7 372.9 3.8 TO	D BE LIGHTED
412 BUILDING 8/31/2022 TRANSITIONAL 354.8 20.8 375.7 369.8 5.8 TO	D BE LIGHTED
413 BUILDING 8/31/2022 TRANSITIONAL 355.8 19.8 375.6 372.1 3.5 TO	D BE LIGHTED
414 TREE 8/31/2022 TRANSITIONAL 355.6 57.2 412.8 362.8 49.9 TO I	BE REMOVED
415 TREE 8/31/2022 TRANSITIONAL 361.0 36.1 397.1 399.3 -2.2 NO.0	OBSTRUCTION
416 TREE 8/31/2022 TRANSITIONAL 358.7 41.9 400.6 361.6 39.0 TO	BE REMOVED
417 TREE 8/31/2022 TRANSITIONAL 358.9 32.7 391.6 362.2 29.4 TO I	BE REMOVED
418 TREE 8/31/2022 TRANSITIONAL 356.0 25.2 381.2 382.9 -1.7 NO C	OBSTRUCTION
419 TREE 8/31/2022 TRANSITIONAL 361.7 17.8 379.5 386.2 -6.7 NO.0	OBSTRUCTION
420 TREE 8/31/2022 TRANSITIONAL 360.1 48.5 408.6 363.0 45.6 TO	BE REMOVED
421 TREE 8/31/2022 TRANSITIONAL 361.0 63.3 424.3 363.8 60.5 TO	BE REMOVED
422 TREE 8/31/2022 TRANSITIONAL 360.7 22.3 383.0 363.3 19.7 TO	BE REMOVED
423 TREE 8/31/2022 TRANSITIONAL 361.3 17.9 379.1 364.6 14.5 TO	BE REMOVED
424 TREE 8/31/2022 TRANSITIONAL 364.2 15.6 379.9 388.0 -8.1 NO.C	OBSTRUCTION
425 TREE 8/31/2022 TRANSITIONAL 363.2 27.3 390.5 368.6 21.9 TO	BE REMOVED
426 TREE 8/31/2022 TRANSITIONAL 364.8 21.7 386.5 384.1 2.4 TO	BE REMOVED
427 TREE 8/31/2022 TRANSITIONAL 364.8 18.7 383.5 381.1 2.4 TO	BE REMOVED
428 TREE 8/31/2022 TRANSITIONAL 367.8 22.8 390.6 383.5 7.1 TO	BE REMOVED
429 TREE 8/31/2022 TRANSITIONAL 367.3 30.2 397.4 384.3 13.2 TO	BE REMOVED
430 TREE 8/31/2022 TRANSITIONAL 367.7 18.0 385.6 371.0 14.6 TO	BE REMOVED
431 TREE 8/31/2022 TRANSITIONAL 367.6 21.2 388.7 370.7 18.1 TO	BE REMOVED
432 TREE 8/31/2022 TRANSITIONAL 367.7 20.3 388.1 370.8 17.3 TO	BE REMOVED
433 TREE 8/31/2022 TRANSITIONAL 369.7 31.1 400.9 406.5 -5.6 NO C	OBSTRUCTION
434 TREE 8/31/2022 TRANSITIONAL 370.3 26.2 396.5 388.1 8.4 TO	BE REMOVED
435 TREE 8/31/2022 TRANSITIONAL 369.0 20.5 389.6 372.0 17.6 TO I	BE REMOVED
436 TREE 8/31/2022 TRANSITIONAL 368.8 28.6 397.4 372.9 24.5 TO	BE REMOVED
437 TREE 8/31/2022 TRANSITIONAL 369.3 56.2 425.5 372.2 53.3 TO	BE REMOVED
438 TREE 8/31/2022 TRANSITIONAL 370.5 48.6 419.1 373.4 45.6 TO I	BE REMOVED
439 WINDSOCK 8/31/2022 TRANSITIONAL 370.2 20.2 390.3 387.0 3.3 TO	D BE LIGHTED
440 TREE 8/31/2022 TRANSITIONAL 372.6 20.2 392.8 375.1 17.7 TO I	BE REMOVED
441 TREE 8/31/2022 TRANSITIONAL 372.6 16.7 389.4 375.2 14.2 TO I	BE REMOVED
	BE REMOVED
443 TREE 8/31/2022 TRANSITIONAL 372.0 31.9 404.0 393.8 10.1 TO I	BE REMOVED

NOTES:

- 1. AIRPORT ELEVATION AND LOCATION DETAILS VERIFIED THROUGH AN AIRPORTS GIS SURVEY (FAA APPROVED 7/27/23).
- OBSTACLES #107-113 ARE LISTED AS ULTIMATE PRIMARY SURFACE OBSTRUCTIONS; THESE ITEMS PENETRATE THE EXISTING RWY 24 APPROACH SURFACE.

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VERIFY SCALES BAR IS ONE INCH ON ORIGINAL DRAWING.
O" 1" 1"
IF NOT ONE INCH ON THIS SHEET, ADJUST SCALES ACCORDINGLY.

FEDERAL AVIATION ADMINISTRATION APPROVAL APPROVAL DATE: ____

SIGNATURE

APPROVAL APPROVAL DATE: ___

LEWIS COUNTY



BEND, OR 97702

E N G I N E E R I N G 541.322.8962 OFFICE FEBRUARY 2024 3-53-0078-013-2022

<	JRAFT
SOUTH LEWIS COUNTY AIRPORT	FIGURE NO.

ED CARLSON MEMORIAL FIELD SHEET NO. AIRSPACE OBSTRUCTION DATA TABLES 13 OF 14

RUNWAY 6 DEPARTURE SURFACE OBSTRUCTIONS									
OBSTACLE ID	DESCRIPTION	SURVEY DATE	SURFACE	GROUND ELEVATION (FT)	AGL (FT)	TOP HEIGHT (FT)	SURFACE HEIGHT (FT)	PENETRATION (FT)	DISPOSITION
603	TREE	8/31/2022	DEPART-SECT 1	346.4	112.8	459.1	465.3	-6.2	NO OBSTRUCTION
601	PRIMARY ROAD	8/31/2022	DEPART-SECT 2N	382.5	15.0	397.5	572.1	-174.6	NO OBSTRUCTION
600	PRIMARY ROAD	8/31/2022	DEPART-SECT 2S	331.9	15.0	346.9	558.8	-211.9	NO OBSTRUCTION
602	PRIMARY ROAD	8/31/2022	DEPART-SECT 2S	324.0	15.0	339.0	603.1	-264.1	NO OBSTRUCTION
604	PRIMARY ROAD	8/31/2022	DEPART-SECT 1	318.0	15.0	333.0	680.8	-347.8	NO OBSTRUCTION

RUNWAY 24 DEPARTURE SURFACE OBSTRUCTIONS									
OBSTACLE ID	DESCRIPTION	SURVEY DATE	SURFACE	GROUND ELEVATION (FT)	AGL (FT)	TOP HEIGHT (FT)	SURFACE HEIGHT (FT)	PENETRATION (FT)	DISPOSITION
202	TREE	8/31/2022	DEPART-SECT 2S	353.8	8.6	362.4	368.7	-6.3	NO OBSTRUCTION
700	PRIMARY ROAD	8/31/2022	DEPART-SECT 2S	354.0	15.0	369.0	515.3	-146.3	NO OBSTRUCTION
701	TREE	8/31/2022	DEPART-SECT 2S	350.8	53.7	404.5	410.4	-5.9	NO OBSTRUCTION
702	PRIMARY ROAD	8/31/2022	DEPART-SECT 2S	352.5	15.0	367.5	510.7	-143.2	NO OBSTRUCTION
703	TREE	8/31/2022	DEPART-SECT 2S	349.4	19.7	369.1	376.6	-7.5	NO OBSTRUCTION
704	TREE	8/31/2022	DEPART-SECT 2S	353.0	23.4	376.5	382.2	-5.7	NO OBSTRUCTION
705	TREE	8/31/2022	DEPART-SECT 2S	350.6	50.9	401.6	399.2	2.3	TO BE REMOVED
706	TREE	8/31/2022	DEPART-SECT 2S	345.8	62.7	408.5	408.3	0.3	TO BE REMOVED
707	TREE	8/31/2022	DEPART-SECT 2S	349.7	70.5	420.2	406.3	13.9	TO BE REMOVED
708	TREE	8/31/2022	DEPART-SECT 2S	346.7	75.9	422.7	409.8	12.9	TO BE REMOVED
709	TREE	8/31/2022	DEPART-SECT 2S	345.2	79.8	425.0	410.6	14.4	TO BE REMOVED
710	TREE	8/31/2022	DEPART-SECT 2S	346.9	81.2	428.1	411.1	17.0	TO BE REMOVED
711	TREE	8/31/2022	DEPART-SECT 2S	342.4	91.7	434.1	412.2	21.9	TO BE REMOVED
712	TREE	8/31/2022	DEPART-SECT 2S	343.8	101.7	445.5	413.7	31.8	TO BE REMOVED
713	TREE	8/31/2022	DEPART-SECT 2S	344.3	100.8	445.2	415.5	29.7	TO BE REMOVED
714	TREE	8/31/2022	DEPART-SECT 2S	347.0	101.5	448.5	416.3	32.2	TO BE REMOVED
715	PRIMARY ROAD	8/31/2022	DEPART-SECT 2S	348.0	15.0	363.0	575.9	-212.9	NO OBSTRUCTION
716	TREE	8/31/2022	DEPART-SECT 2S	341.6	87.7	429.4	417.9	11.5	TO BE REMOVED
717	TREE	8/31/2022	DEPART-SECT 2S	345.1	98.6	443.7	417.7	26.0	TO BE REMOVED
718	TREE	8/31/2022	DEPART-SECT 2S	345.0	93.2	438.2	418.7	19.5	TO BE REMOVED
719	TREE	8/31/2022	DEPART-SECT 2S	343.4	71.3	414.7	420.7	-6.0	NO OBSTRUCTION
720	TREE	8/31/2022	DEPART-SECT 2S	342.7	83.3	426.0	423.6	2.4	TO BE REMOVED
721	TREE	8/31/2022	DEPART-SECT 2S	341.1	78.3	419.4	422.5	-3.1	NO OBSTRUCTION
722	PRIMARY ROAD	8/31/2022	DEPART-SECT 2S	346.0	15.0	361.0	582.5	-221.4	NO OBSTRUCTION
723	TREE	8/31/2022	DEPART-SECT 2S	345.1	108.2	453.3	426.6	26.8	TO BE REMOVED
724	TREE	8/31/2022	DEPART-SECT 2S	343.6	129.9	473.5	427.2	46.3	TO BE REMOVED
725	TREE	8/31/2022	DEPART-SECT 2S	343.6	130.6	474.2	475.6	-1.4	NO OBSTRUCTION
726	TREE	8/31/2022	DEPART-SECT 2S	342.3	114.7	457.1	431.9	25.1	TO BE REMOVED
727	TREE	8/31/2022	DEPART-SECT 2S	342.1	103.7	445.8	432.9	13.0	TO BE REMOVED
728	TREE	8/31/2022	DEPART-SECT 2S	344.7	102.5	447.2	438.2	9.0	TO BE REMOVED
729	TREE	8/31/2022	DEPART-SECT 2S	344.0	104.4	448.4	439.5	8.9	TO BE REMOVED
730	TREE	8/31/2022	DEPART-SECT 2S	343.2	91.5	434.7	440.5	-5.8	NO OBSTRUCTION
731	TREE	8/31/2022	DEPART-SECT 2S	341.7	124.6	466.3	438.8	27.5	TO BE REMOVED
732	PRIMARY ROAD	8/31/2022	DEPART-SECT 2S	333.0	15.0	348.0	598.2	-250.2	NO OBSTRUCTION
733	PRIMARY ROAD	8/31/2022	DEPART-SECT 2S	328.6	15.0	343.6	659.3	-315.7	NO OBSTRUCTION
734	PRIMARY ROAD	8/31/2022	DEPART-SECT 2S	327.0	15.0	342.0	659.3	-317.3	NO OBSTRUCTION
735	PRIMARY ROAD	8/31/2022	DEPART-SECT 2S	318.0	15.0	333.0	659.3	-326.3	NO OBSTRUCTION

"THE PREPARATION OF THIS DOCUMENT MAY HAVE BEEN SUPPORTED, IN PART, THROUGH THE AIRPORT IMPROVEMENT PROGRAM FINANCIAL ASSISTANCE FROM THE FEDERAL AVIATION ADMINISTRATION (PROJECT NUMBER 3-53-0078-013-2022) AS PROVIDED UNDER TITLE 49, UNITED STATES CODE, SECTION 47104. THE CONTENTS DO NOT NECESSARILY REFLECT THE OFFICIAL VIEWS OR POLICY OF THE FAA. ACCEPTANCE OF THIS REPORT BY THE FAA DOES NOT IN ANY WAY CONSTITUTE A COMMITMENT ON THE PART OF THE UNITED STATES TO PARTICIPATE IN ANY DEVELOPMENT DEPICTED THEREIN NOR DOES IT INDICATE THAT THE PROPOSED DEVELOPMENT IS ENVIRONMENTALLY ACCEPTABLE IN ACCORDANCE WITH APPROPRIATE PUBLIC LAWS."

NO.	DATE	BY	APPR	REVISIONS	
					VERIFY SCALES
					BAR IS ONE INCH ON ORIGINAL DRAWING.
					0" 1" IF NOT ONE INCH ON
					THIS SHEET, ADJUST
					SCALES ACCORDINGLY.

FEDERAL AVIATION MINISTRATION APPROVAL	LEWIS COUNTY APPROVAL
AL DATE:	APPROVAL DATE:
SIGNATURE	SIGNATURE

	CENTUR WEST	SUITE #100	1020 SW EMKAY DRIVE	
ENG	INEERIN			
SIGNED BY: DM	DRAWN BY: JLS / ES	CHECKED BY: WMR	SCALE: AS SHOWN	
TE: FEBRUA	RY 2024	PROJECT NO: 3-53-	0078-013-2022	

	Ok.
SOUTH LEWIS COUNTY AIRPORT	FIGURE NO.
ED CARLSON MEMORIAL FIELD	

AIRSPACE OBSTRUCTION DATA TABLES

SHEET NO.

14 OF 14